


DESCRIPTION: LBNF HE PID  
 PROJECT: PROJ  
 CATEGORY: P&ID


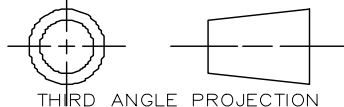
REV	REVISION CONTROL DOCUMENT	DATES	SIGNATURES	
-	F10146800---RCD	-	DRAWN	-
			APPROVED	-

### DECAY VOLUME HELIUM FILL

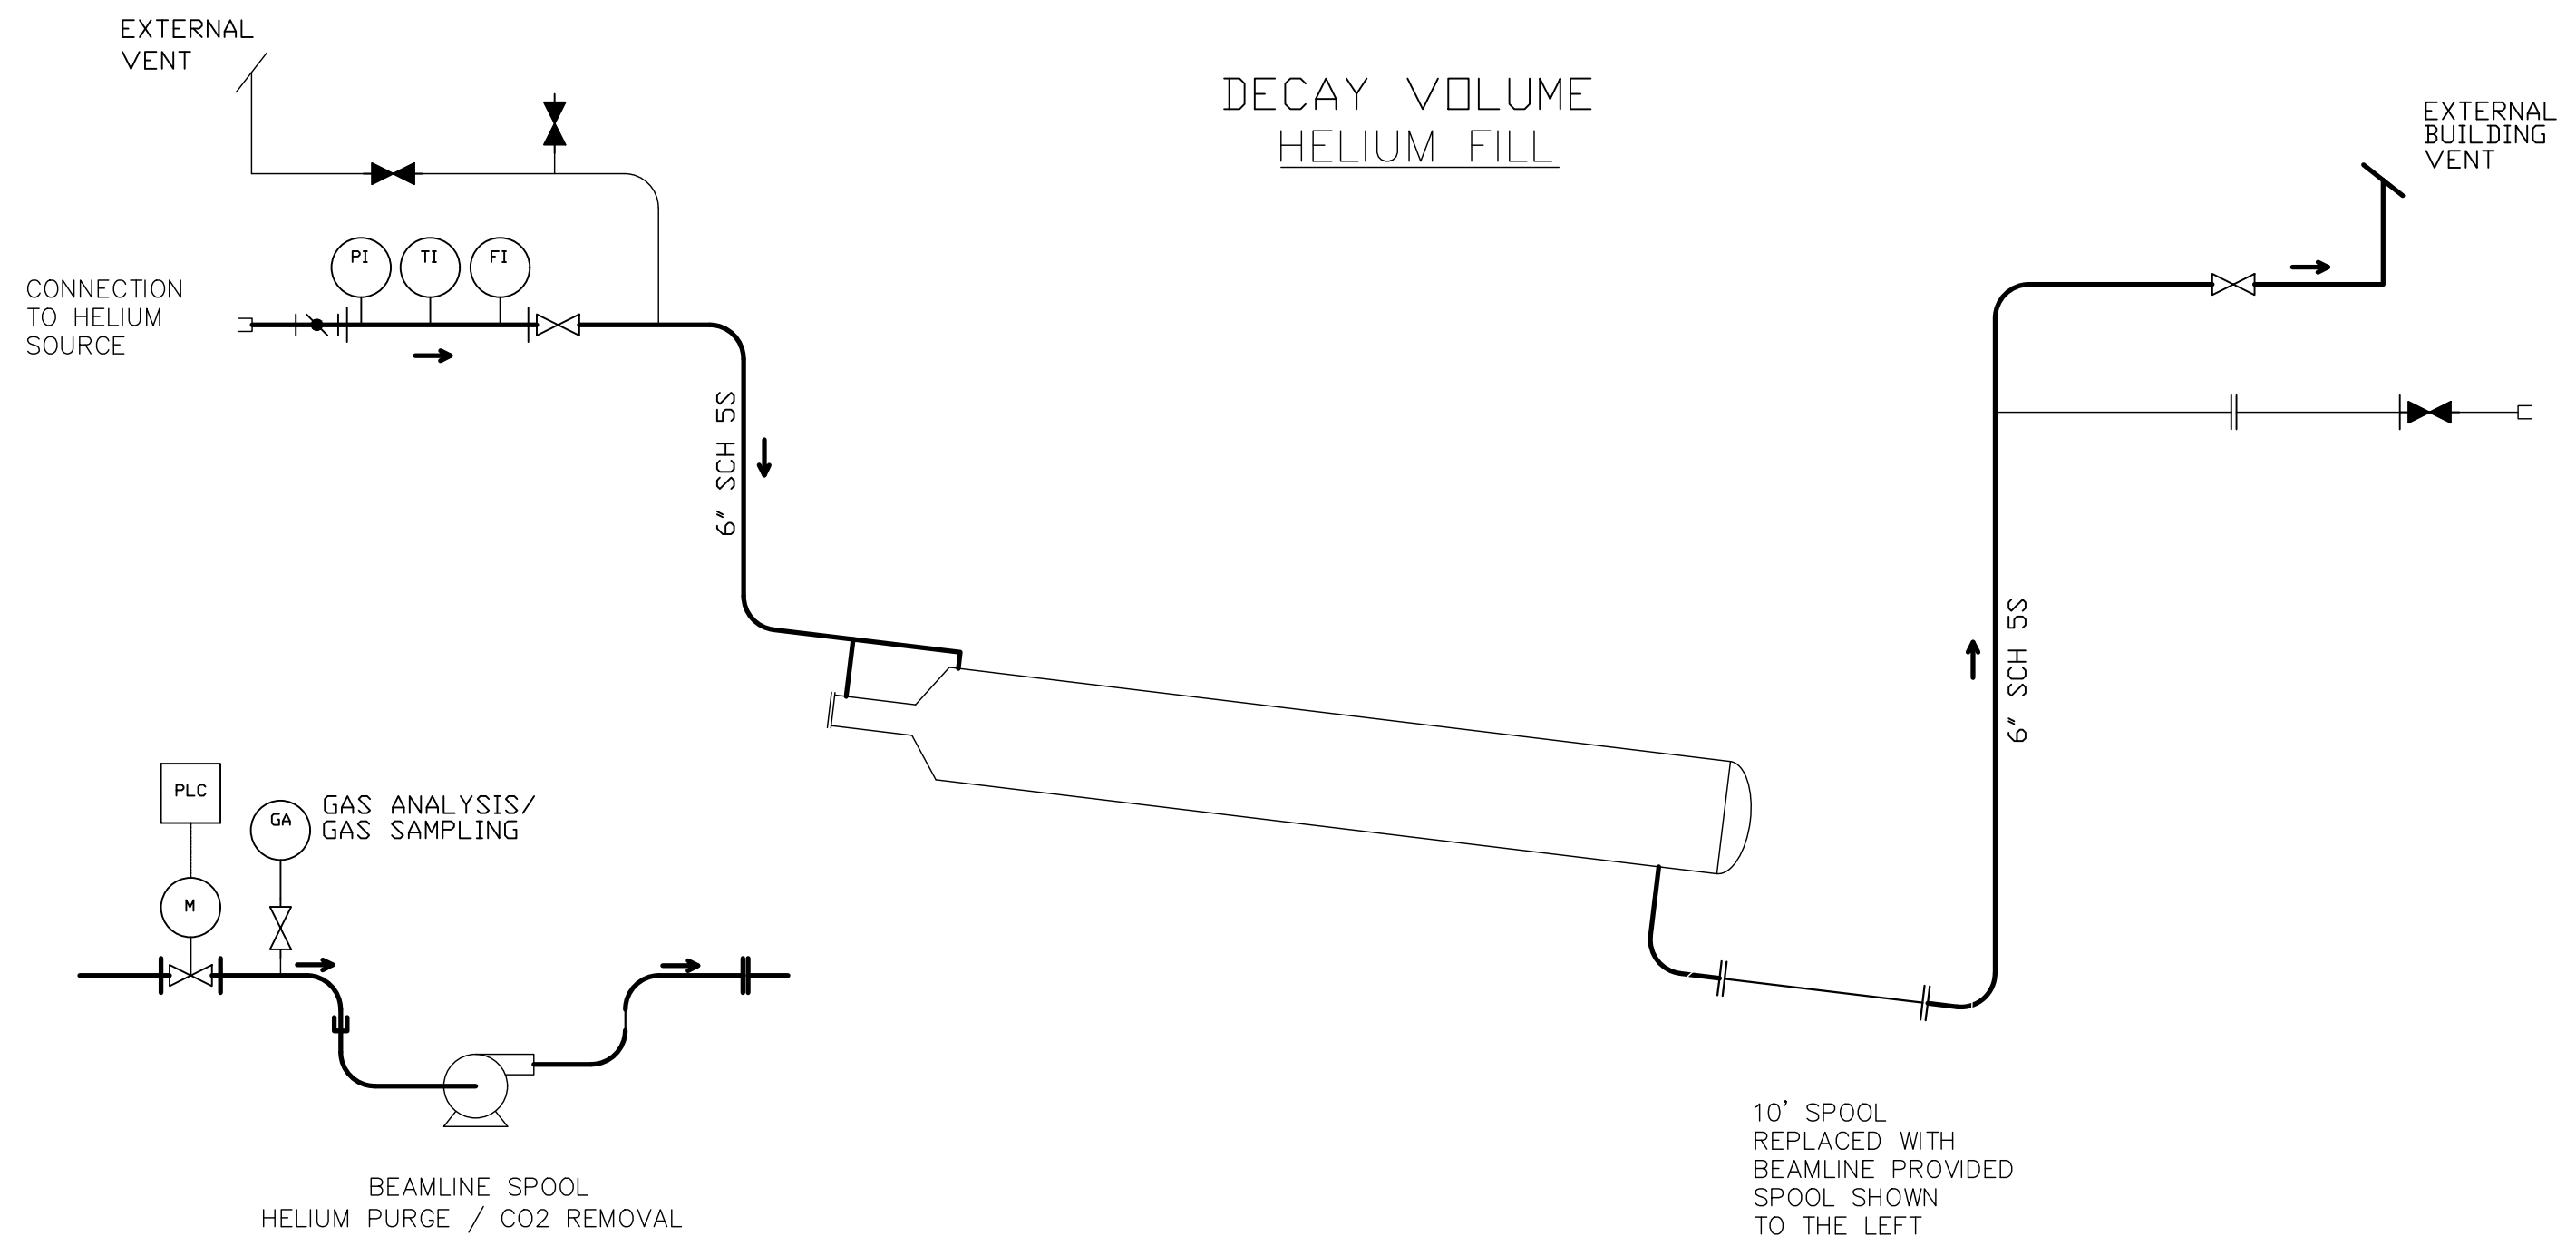

10' SPOOL  
 REPLACED WITH  
 BEAMLINE PROVIDED  
 SPOOL SHOWN  
 TO THE LEFT

TEMPLATE VERSION: ACAD Nov 21, 2018

UNLESS OTHERWISE SPECIFIED					DRAWN	R.NOCEDA		DATE	12-OCT-2020		 FERMI NATIONAL ACCELERATOR LABORATORY UNITED STATES DEPARTMENT OF ENERGY		
±.X	±.XX	±.XXX	±X/X	±X*	CHECKED			DATE					
.1	.02	.005	1/16	1	APPROVED			DATE					
BREAK ALL SHARP EDGES, MAX:.015 DO NOT SCALE DRAWING DIMENSIONS BASED ON: ASME Y14.5-2009 MAX MACHINE ALL SURFACES: 125 DRAWING UNITS: INCHES					USED ON		N/A		NAME				
 THIRD ANGLE PROJECTION					MATERIAL		N/A		SCALE NTS SIZE B		DRAWING NUMBER F10146800	SHEET 3 OF 3	REV -
GROUP: Technical Division - Design and Drafting					CAGE CODE: OU5R6								

B

B

A

A

4

3

2

1

4

3

2

1